
CONTRACT NO. 62417

17 338 (II3 & II4) R-5 WILL 525 357

STA. 3274+00 TO STA. 3288+00

FER MOND DIST, NO. BLINGES FAP 338 (IL RTE. 59)

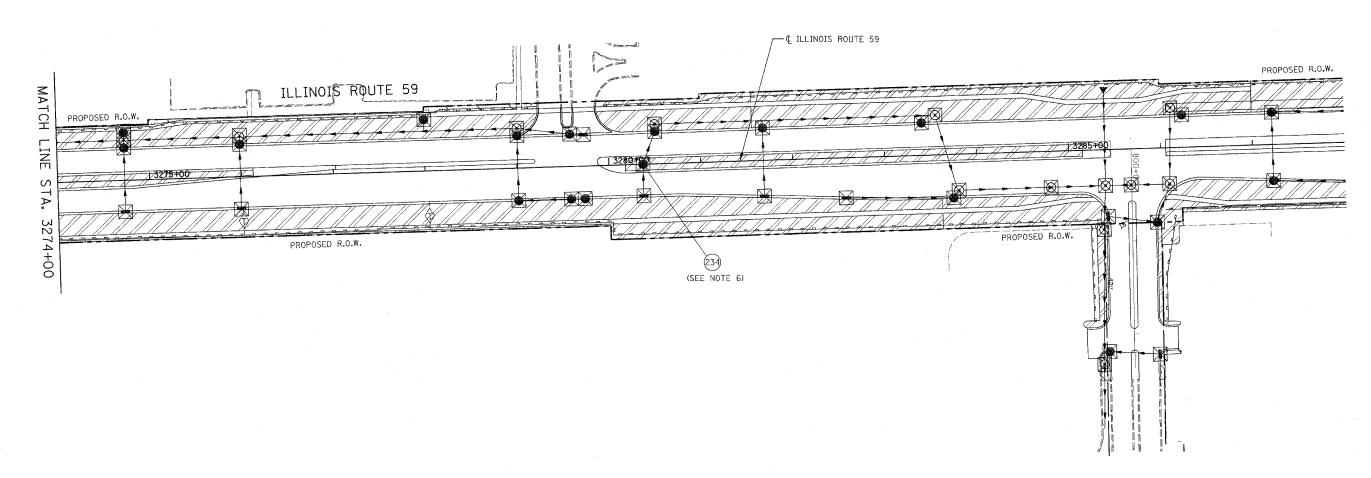



EROSION CONTROL LEGEND

TEMPORARY EROSION CONTROL SEEDING AND EROSION CONTROL BLANKET



TEMPORARY EROSION CONTROL SEEDING AND EROSION CONTROL BLANKET INSTALLED IN PREVIOUS STAGE



PERMANENT LANDSCAPING (SEE NOTE 3)



DRAINAGE STRUCTURE TO BE CLEANED



SEDIMENT CONTROL, SILT FENCE (SEE NOTE 2)

SEDIMENT CONTROL SILT FENCE INSTALLED



INLET FILTER

IN PREVIOUS STAGE



INLET FILTER INSTALLED IN PREVIOUS STAGE



TEMPORARY DITCH CHECK

FLOW DIRECTION (SEE NOTE 4)

TEMPORARY PIPE CULVERT



TEMPORARY DITCH CHECK INSTALLED IN PREVIOUS STAGE



PERMANENT DRAINAGE STRUCTURE NUMBER (SEE SEE NOTE 5)



PROPOSED STORM SEWER (SEE NOTE 5)




PROPOSED STORM SEWER INSTALLED IN PREVIOUS STAGE



TEMPORARY PIPE CULVERT INSTALLED IN PREVIOUS STAGE

NOTES

- THE CONSTRUCTION LIMITS WILL BE STAKED BY THE ENGINEER PRIOR TO COMMENCING CONSTRUCTION. THE CONSTRUCTION LIMITS MAY BE ADJUSTED BY THE ENGINEER TO PRESERVE TREES AND NO ADDITIONAL COMPENSATION WILL BE PAID TO THE CONTRACTOR FOR CHANGED CONSTRUCTION LIMITS.
- SEDIMENT CONTROL, SILT FENCE SHALL BE ERECTED ADJACENT TO R.O.W., EASEMENT, AND CONTRUCTION LIMITS AND AS DIRECTED BY THE ENGINEER.
- 3. SEE LANDSCAPING PLANS FOR LANDSCAPING REQUIREMENTS.
- 4. SEE STAGE 3 OF THE FINAL CROSS SECTIONS FOR GRADING INFORMATION.
- 5. SEE PROPOSED DRAINAGE PLANS FOR STORM SEWER INFORMATION.
- 6. ANY REQUIRED ADJUSTMENT AND/OR RECONSTRUCTION OF THE PROPOSED STRUCTURE TO FINAL RIM ELEVATION SHALL NOT BE PAID FOR SEPARATELY. THE COST FOR THIS WORK SHALL BE CONSIDERED INCLUDED IN THE COST OF THE PROPOSED STRUCTURE.

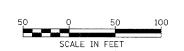

ILLINOIS DEPARTMENT OF TRANSPORTATION DISTRICT NO. 1 SCHAUMBURG EROSION CONTROL PLAN STAGES 3, 3A AND 3B ILLINOIS ROUTE 59

SCALE AS SHOWN
DATE MARCH 18, 2008

DRAWN BY REW
CHECKED BY JCM